PART II GENERAL SECTION

QUESTION 9 - MAPS

The following maps must be provided as a part of the ADA. The appropriate scale for each map should be determined at the pre-application conference.

Map A. A general location map. Indicate the location of any urban service area boundaries and regional activity centers near the project site.

See attached <u>Map A: Location Map</u>. There are no urban service area boundaries or regional activity centers near the project site.

Map B. A recent vertical aerial photo of the site showing project boundaries which reasonably reflects current conditions. Specify the date the photo was taken.

See attached Map B: Aerial.

Map C. A topographic map with project boundaries identified (contour intervals from one to five feet should be determined in consultation with the appropriate regional planning council and other reviewing agencies at the pre-application conference). Delineate 100-year flood prone areas (including hurricane flood zones) and indicate major land surface features. If applicable, delineate the coastal construction control line.

See attached Map C: Topographic Map.

Map D. A land use map showing existing and approved uses on and abutting the site. The uses shown should include existing on-site land uses, recreational areas, utility and drainage easements, wells, right-of-way, and historic, archaeological, scientific and architecturally significant resources and lands held for conservation purposes.

See <u>Map D-1: Future Land Use</u> and <u>D-2: Existing Land Use</u> attached. There are no recreational areas, utility and drainage easements, wells, right-of-way, and historic, archaeological, scientific and architecturally significant resources existing on or abutting the project site. The wetland area within the project site will remain preserved.

Map E. A soils map of the site, with an identification of the source of the information. The use of a source other than the most recently published U.S.D.A. Soil Conservation Service (SCS) soil surveys should be determined in consultation with the appropriate regional planning council and other reviewing agencies at the pre-application conference.

See attached Map E: Soils.

Question 9 - Maps Page 9-1

Map F. A vegetation associations map indicating the total acreage of each association, based on the Level III vegetation types described in The Florida Land Use and Cover Classification System: A Technical Report, available from each regional planning council.

See attached Map F: Vegetation Associations.

Map G. A location map of all transects, trap grids, or other sampling stations used to determine the on-site status of significant wildlife and plant resources. Show location of all observed significant wildlife and plant resources, and show location of suitable habitat for all significant resources expected to be on-site.

See attached Map G: Wildlife and Plant Resources.

Map H. A master development plan for the site. Indicate proposed land uses and locations, development phasing, major public facilities, utilities, preservation areas, easements, right-of-way, roads, and other significant elements such as transit stops, pedestrian ways, etc. This plan will provide the basis for discussion in Question 10-A as well as other questions in the ADA.

See attached Map H: Master Development Plan.

Map I. A master drainage plan for the site. Delineate existing and proposed: drainage basins, flow direction, water retention areas, drainage structures, flow route offsite, drainage easements, waterways, and other major drainage features.(This information may be presented on two separate maps (existing and proposed), if desired.)


See Map I: Master Drainage Map.

Map J. A map of the existing highway and transportation network within the study area. The study area includes the site, and locations of all transportation facilities which are substantially impacted. This area should be finally defined on the basis of the findings of the traffic impact analysis, including determinations of where the criteria for a substantial impact are met. Map J will become the base for the maps requested in Question 21.

See Map J within the Transportation section.

Question 9 - Maps Page 9-2

MAPS

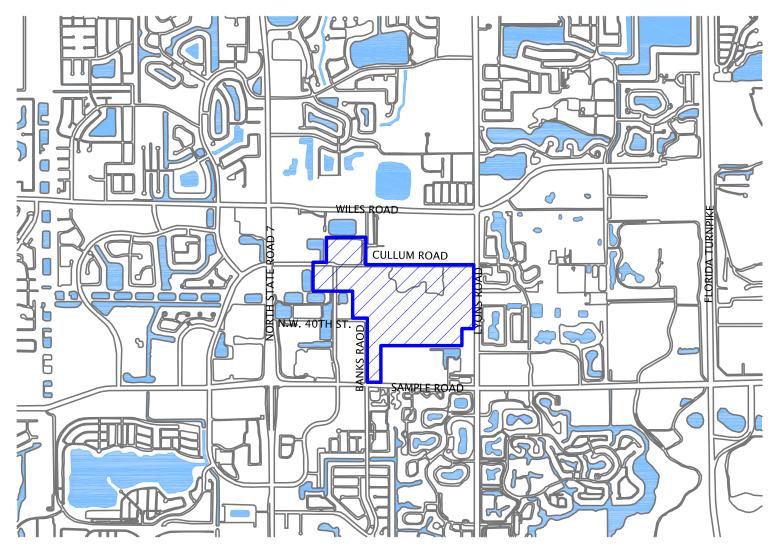

SOURCE: A)GOOGLE EARTH B)LIVEMAPS.COM C)APRIL 2007

MAP A LOCATION


MAIN STREET @ COCONUT CREEK DRI



SCALE: 0'-1" = 2500'-0" DATE: MARCH 27, 2009

Leigh Robinson Kerr & Associates, Inc.

PLANNING-ZONING-LAND USE 808 E. Las Olas Blvd. - Suite 104 Fort Lauderdale, Florida 33301 (954) 467-6308

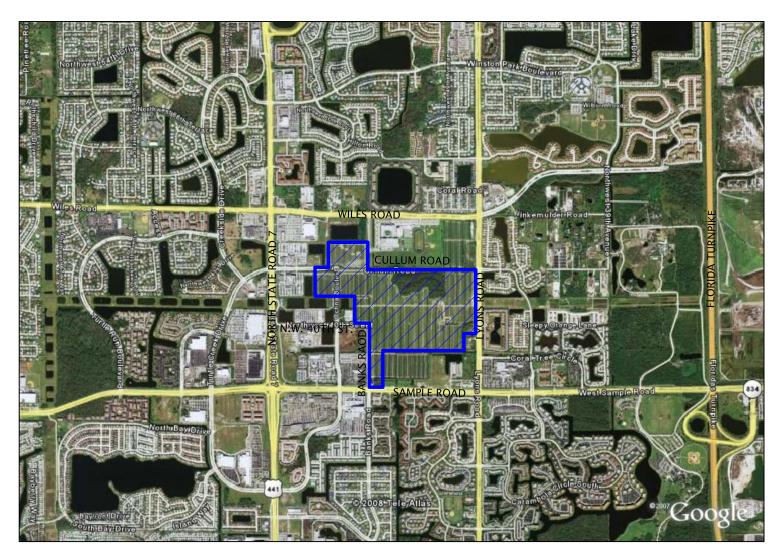

SOURCE: A)GOOGLE EARTH B)LIVEMAPS.COM C)APRIL 2007

MAP B AERIAL


MAIN STREET @ COCONUT CREEK DRI





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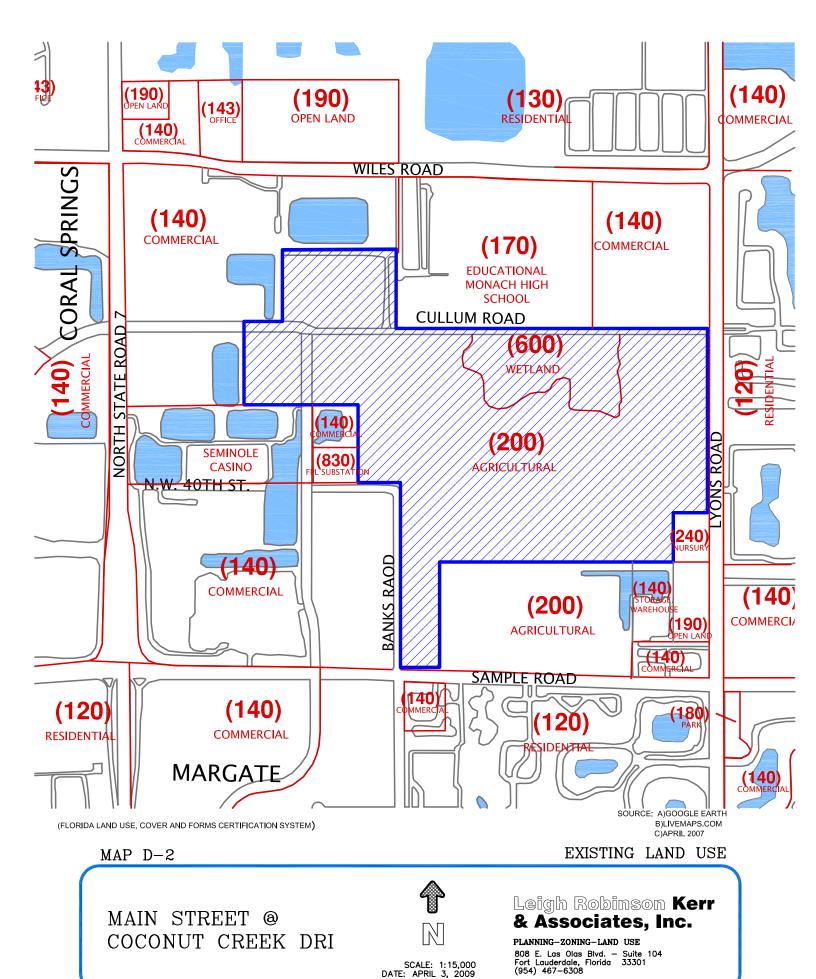


MAIN STREET @ COCONUT CREEK DRI

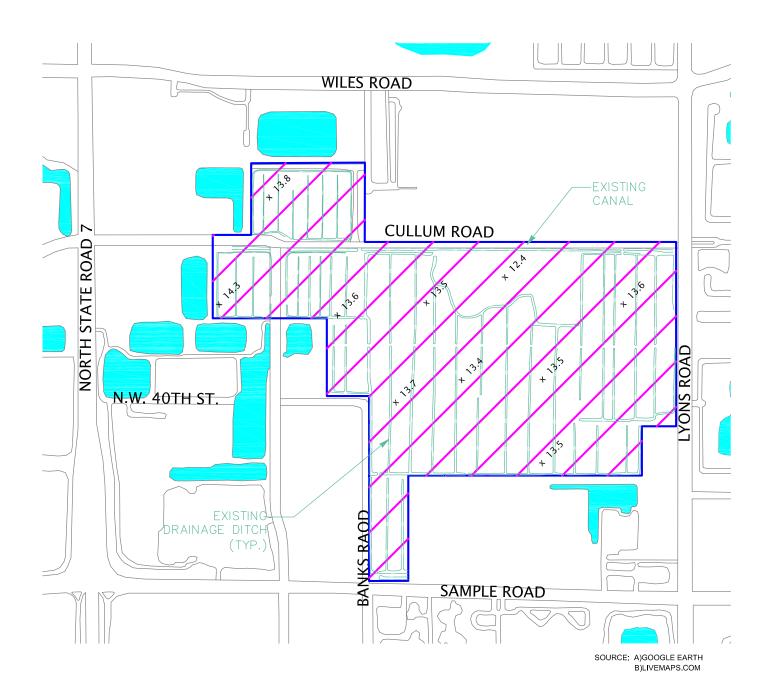


SCALE: 1:15,000 DATE: MARCH 27, 2009 Leigh Robinson Kerr & Associates, Inc.
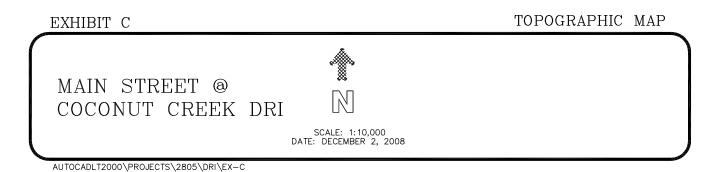
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AUTOCADLT2000\PROJECTS\2805\DRI\EX-D

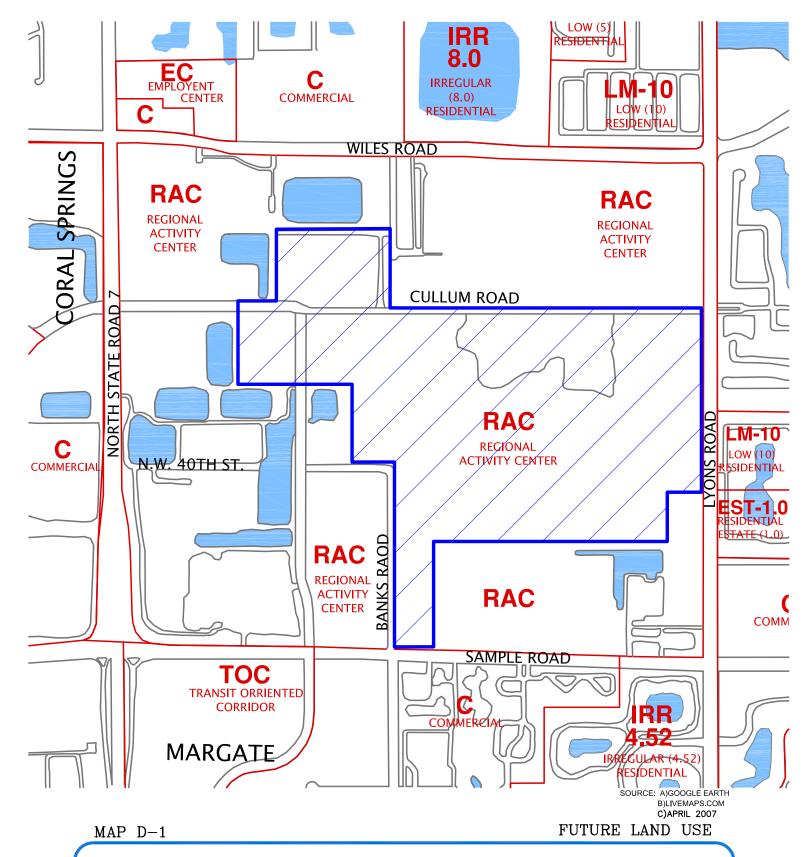

SOURCE: A)GOOGLE EARTH B)LIVEMAPS.COM

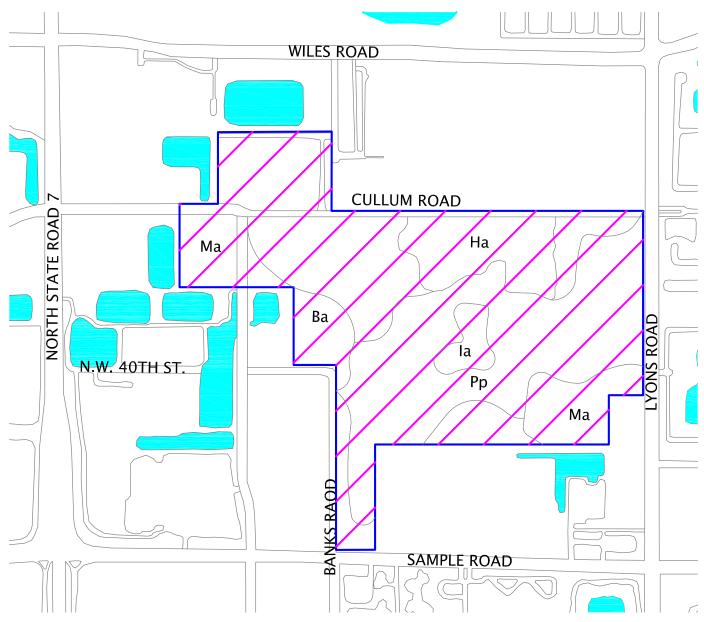
MA - MARGATE FINE SAND HA - HALLANDALE FINE SAND BA - BASINGER FINE SAND IA - IMMOKOLEE FINE SAND PP - POMPANO FINE SAND

SOILS MAP EXHIBIT E

MAIN STREET @ COCONUT CREEK DRI



SCALE: 1:10,000 DATE: DECEMBER 2, 2008

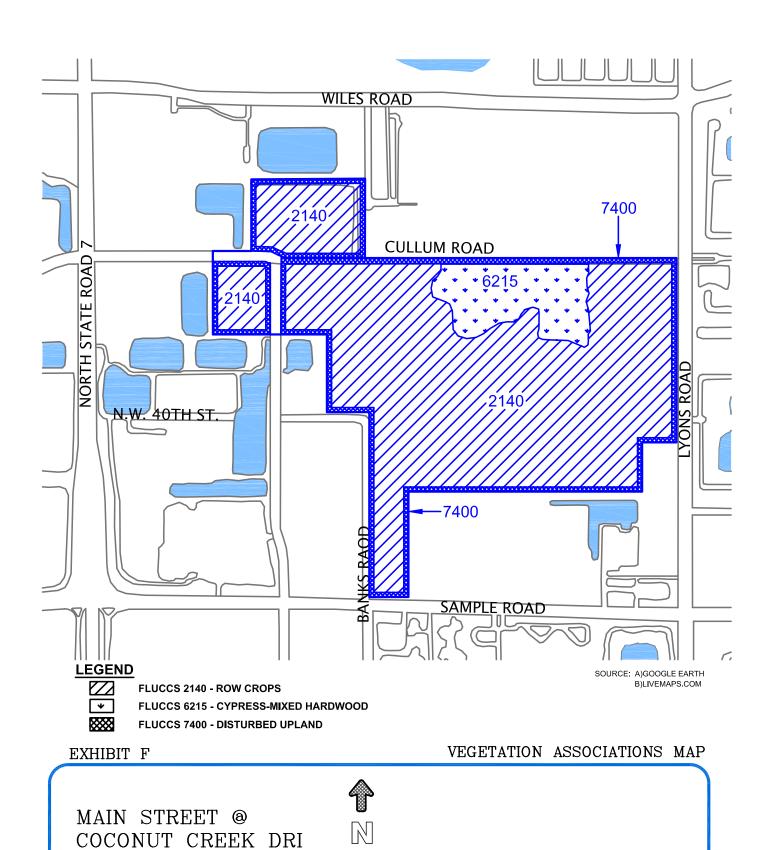

SCALE: 1:10,000 DATE: DECEMBER 2, 2008

AUTOCADLT2000\PROJECTS\2805\DRI\EX-F

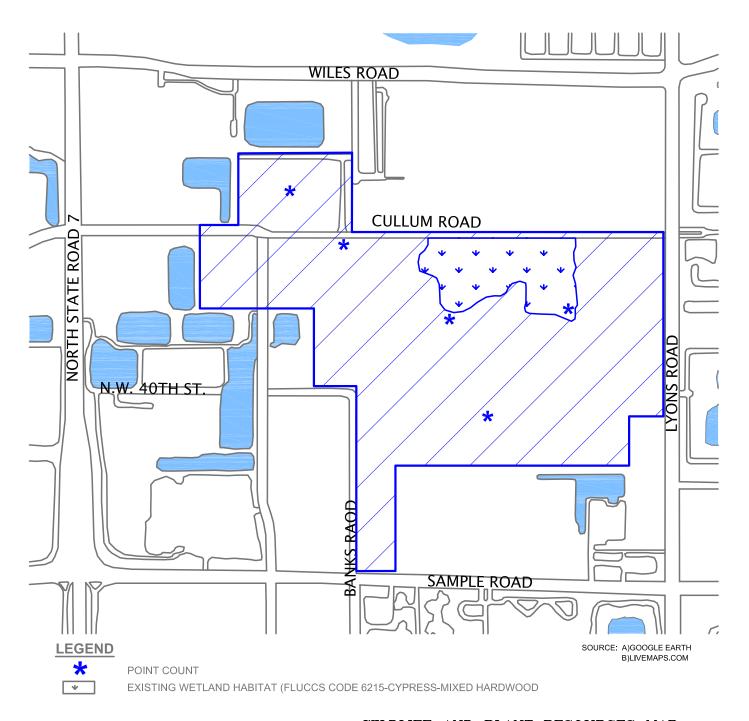



EXHIBIT G

WILDLIFE AND PLANT RESOURCES MAP

MAIN STREET @ COCONUT CREEK DRI



SCALE: 1:10,000 DATE: DECEMBER 2, 2008

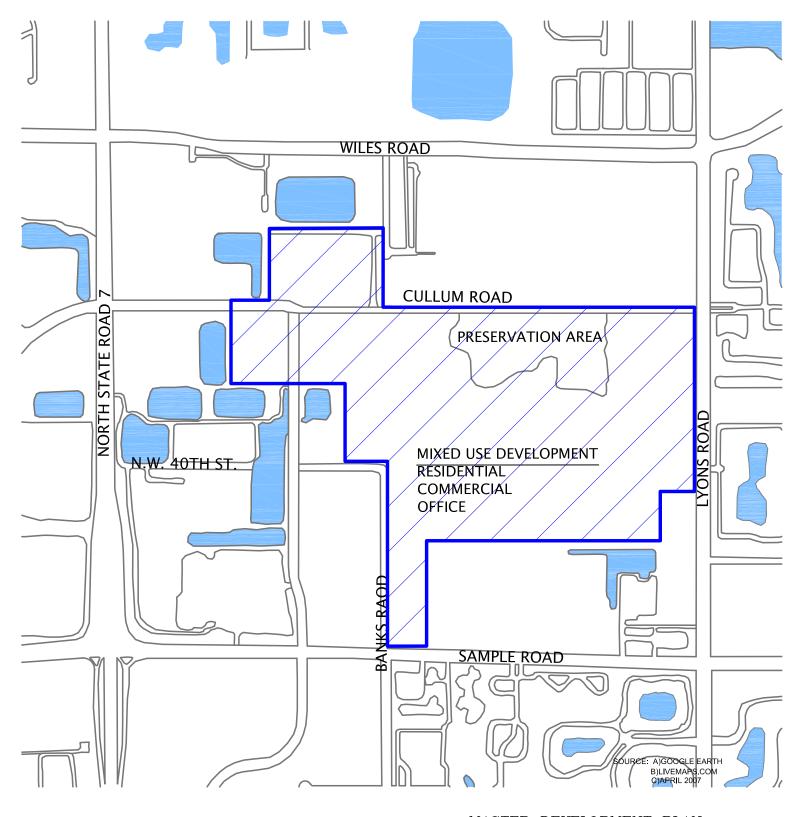

MAP H


MASTER DEVELOPMENT PLAN

MAIN STREET @ COCONUT CREEK DRI



SCALE: 1:10,000 DATE: APRIL 8, 2009 Leigh Robinson Kerr & Associates, Inc.

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NOTE: LAKE SIZE AND LOCATION SUBJECT TO ZONING AND SITE PLAN APPROVAL

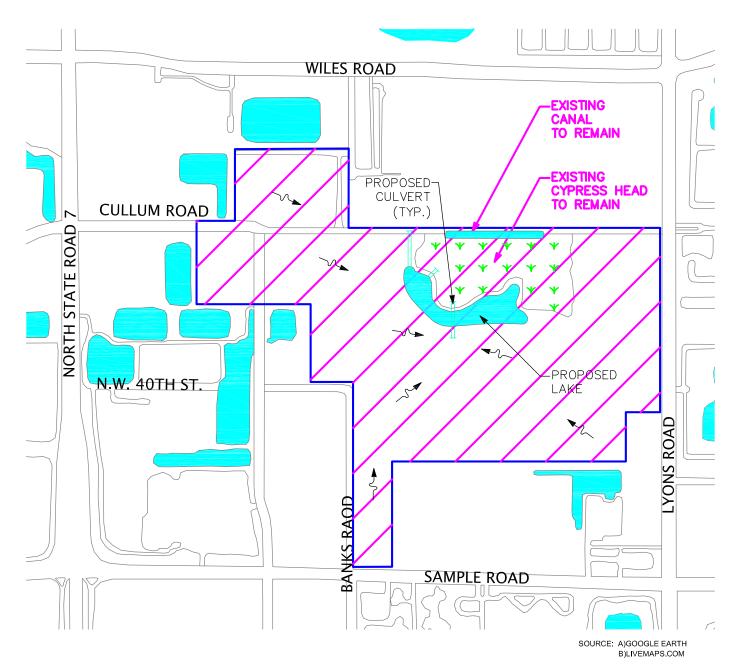MASTER DRAINAGE PLAN MAP








SCALE: 1:10,000 DATE: DECEMBER 2, 2008

AUTOCADLT2000\PROJECTS\2805\DRI\EX-I

EXHIBIT I

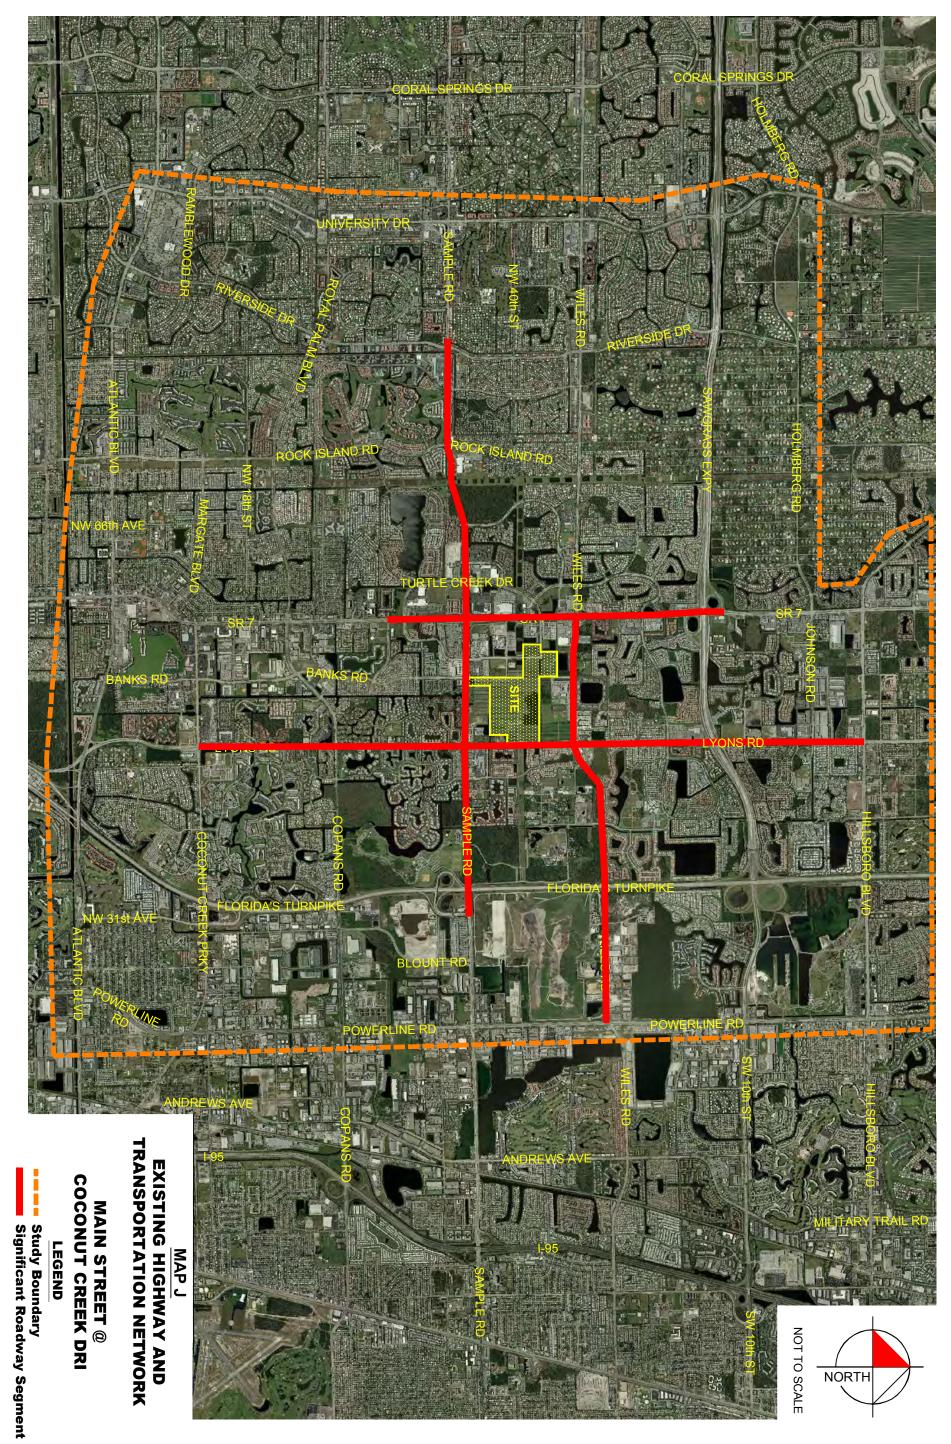

Drawing name: K: FTL_TPT0=043271000-Main Street CC DRI=CADD=Prelim Final study area.dwg Map J-3a Apr 02, 2009 12:49pm